



DETAIL OF MANHOLE # 3  
SCALE 1/2" = 1'-0"

DETAIL OF SUMP #1  
SCALE 1/2" = 1'-0"

SITE PLAN  
SCALE 1" = 30'-0"

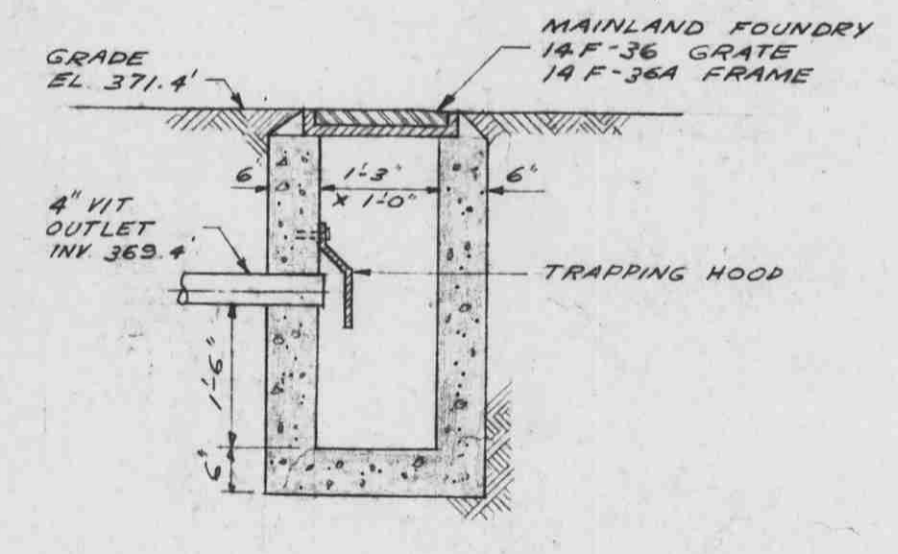

DETAIL OF CATCH BASIN  
SCALE 1/2" = 1'-0"

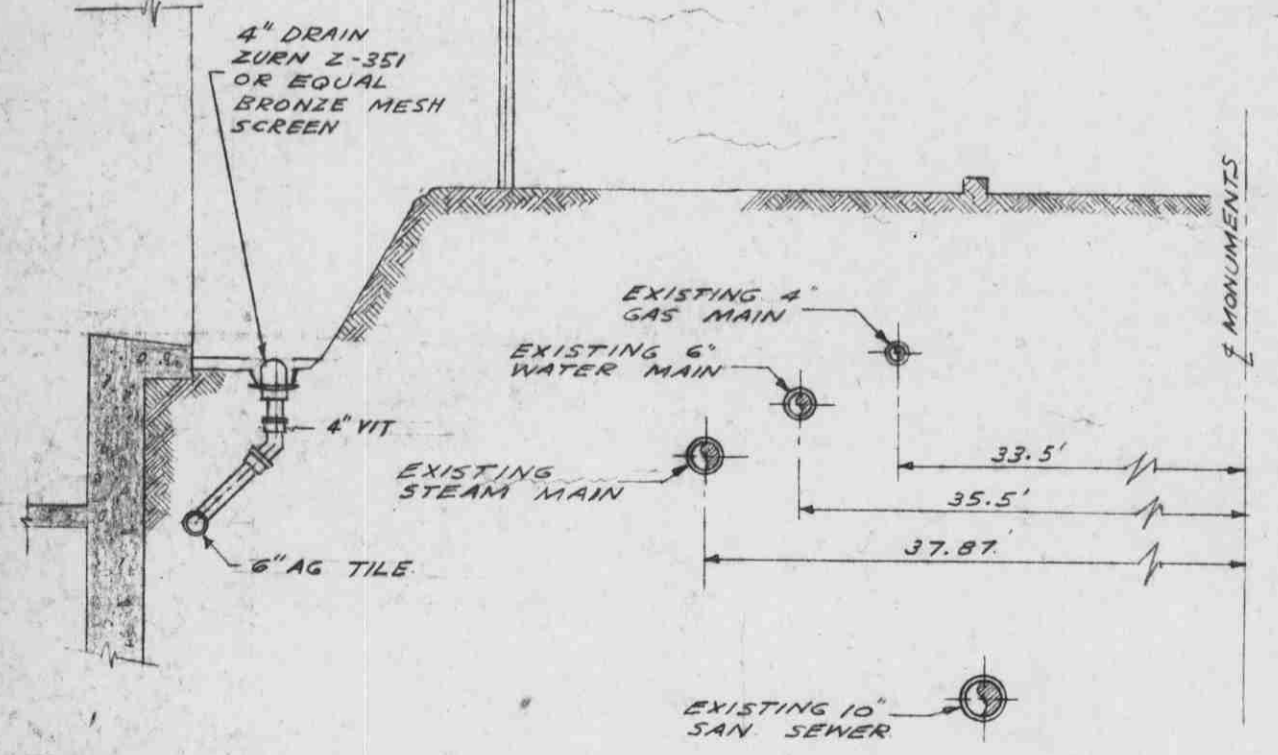

SECTION A-A  
SCALE 1/2" = 1'-0"

- NOTE:**
- 1 ALL ELEVATIONS TO U.B.C. DATUM
  - 2 BEFORE ANY DRAINAGE WORK IS COMMENCED ASCERTAIN THAT THE DEPTHS OF THE MANHOLES, SEWERS AND CONNECTIONS ARE SUCH THAT THE DRAINS CAN BE SATISFACTORILY INSTALLED IN ACCORDANCE WITH THE DRAWINGS.
  - 3 LOCATIONS OF EXISTING SERVICES ARE SHOWN APPROXIMATELY AND ARE TO BE VERIFIED ON JOB.
  - 4 ALL EXISTING TREES TO BE PROTECTED & PRESERVED.
  - 5 ALL EXISTING LINES & DRAINS NOT IN USE TO BE REMOVED.
  - 6 ALL DISRUPTED LINES TO BE MADE GOOD AND RECONNECTED TO SYSTEM.

"SYMBOL SCHEDULE"			
SYMBOL	DESCRIPTION	SYMBOL	DESCRIPTION
—S—S—	SANITARY WASTE	R.D.	ROOF DRAIN
—SW—SW—	STORM WASTE	F.D.	FLOOR DRAIN
—V—V—	VENT	H.D.	HUB DRAIN
—FG—FG—	FOOTING DRAIN	M.H.	MANHOLE
—C.W.—C.W.—	COLD WATER	C.B.	CATCH BASIN
—H.W.—H.W.—	HOT WATER	H.B.	HOSE BIBB
—H.W.R.—H.W.R.—	HOT WATER RETURN	F.H.C.	FIRE HOSE CAB'T.
—WS—WS—	WET STANDPIPE		
—E.L.—E.L.—	EXISTING LINE		

SITE PLAN		PLUMBING		JOB NO. 1287	
D. W. THOMSON & COMPANY LTD. CONSULTING MECHANICAL ENGINEERS 1680 WEST BROADWAY VANCOUVER 9, B.C.		THOMPSON, BERWICK & PRATT ARCHITECTS 1555 ROBSON ST. VANCOUVER 5, B.C.		UNIVERSITY OF BRITISH COLUMBIA LIBRARY	
No.	DATE	REVISION		P-1	SHEET No. OF 5
			DRAWN: D.C.T. CHECKED: J.Y.P. SCALE: AS SHOWN DATE: MAY 15 1959		